


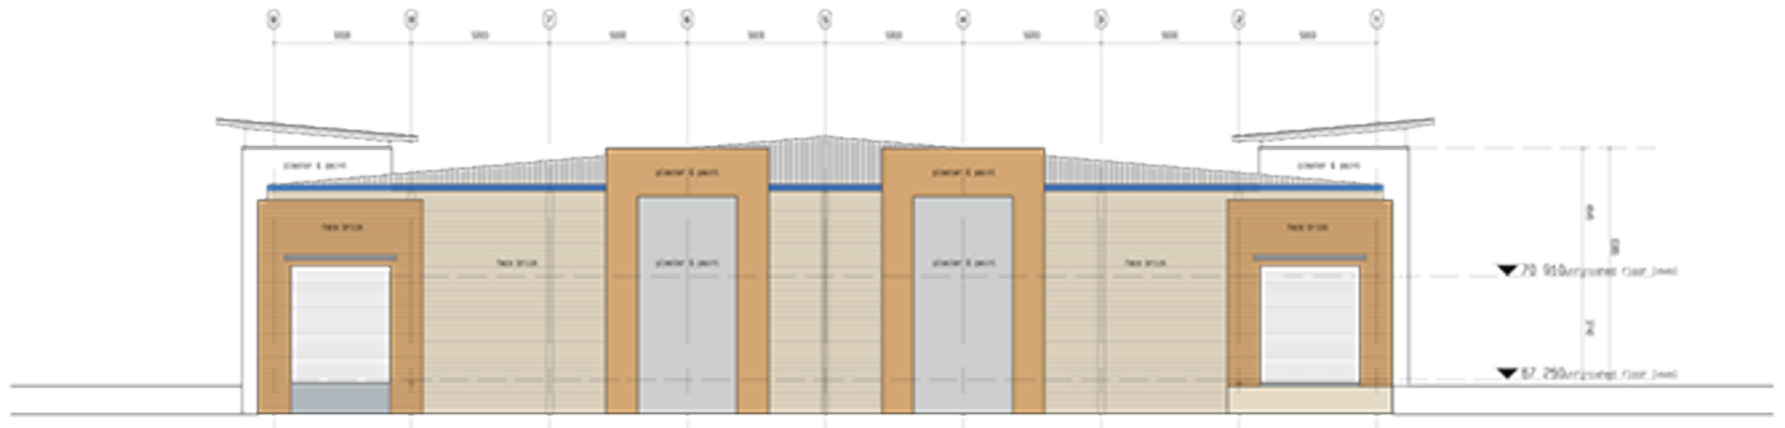

BLOCK A - South Elevation
Scale: 1/8" = 1'-0"



BLOCK A - East Elevation
Scale: 1/8" = 1'-0"



BLOCK A - North Elevation
Scale: 1/8" = 1'-0"



BLOCK A - West Elevation
Scale: 1/8" = 1'-0"

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NO.	DATE	BY	CHKD.	DESCRIPTION
1	10/15/2020	JLW	ML	Final Elevation Drawings

Smart & Associates Architects, Inc.
1111 1st Avenue, Suite 100
Seattle, WA 98101
Tel: 206.461.1111

BLOCK A
ELEVATIONS

0811-401A
DATE: 10/15/2020
SCALE: 1/8" = 1'-0"



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Discipline	Author	Checked	Approved
Architecture			
Structural			
Mechanical			
Electrical			
Water			
Sanitary			
Landscaping			

Project:
New Corporate Office Park for MONEY BOX INVESTMENTS 99 (PTY) LTD on Erf 299 Randjespark EXT. 104



Client:
Site Development Plans

Drawn:
May 2008

Checked:
AS

Scale:
AS SHOWN

Project No:
0811-101

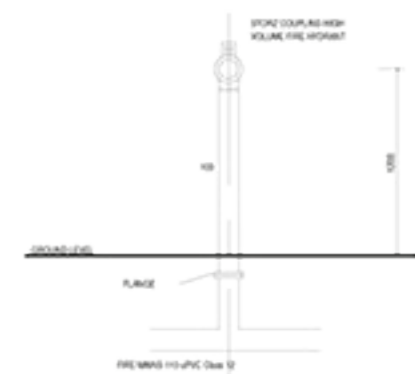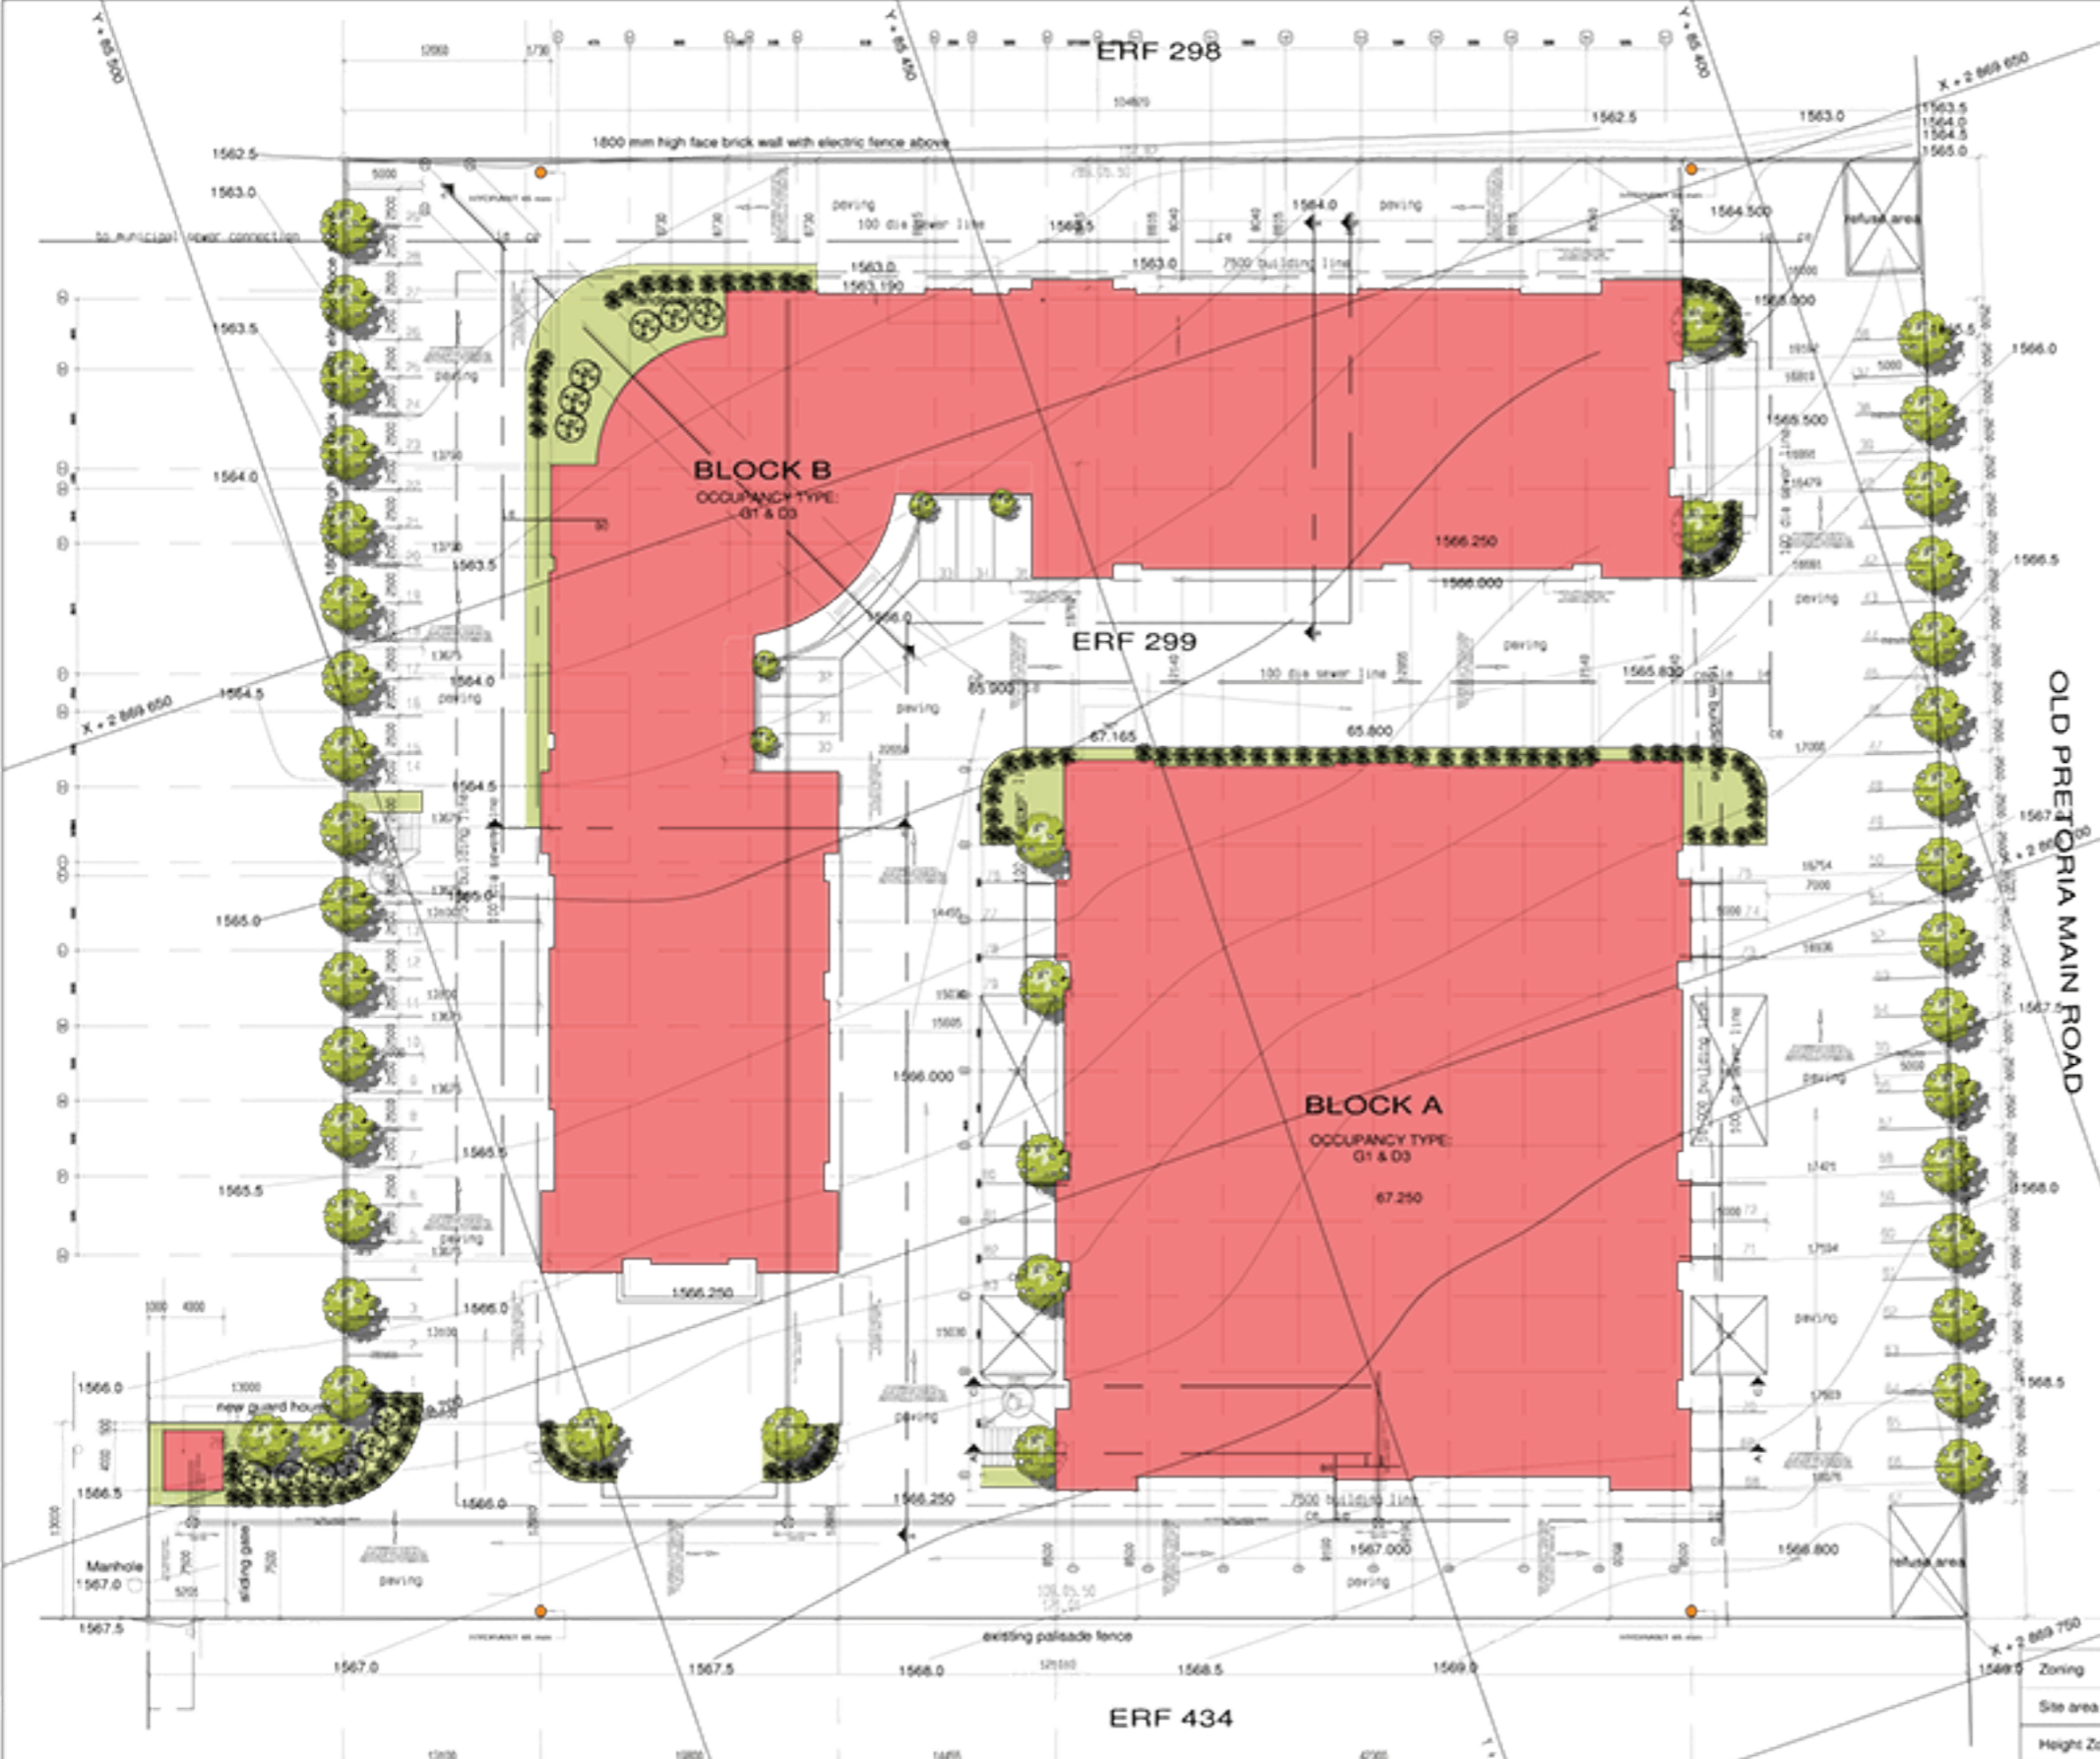


Landscaping legend

	Planter on embankment
	Karee tree
	diets grandiflora
	vittatus 4 x per m2
	nandina pygmaea 4x per m2
	flood plain



fire requirements:

- It is the appointed fire protection consultant's responsibility to see that all fire requirements are met and must inform the architect and contractor in this regard. All architectural drawings must be checked by this consultant to see that all requirements are met!
- HYDRANT 65 mm
 - 30m x 25mm FIRE HOSE REEL
- 1) general requirements
 - 2) safety distances
 - 3) structural steel
 - 4) fire performance - general
 - 5) fire stability of structural elements or components
 - 6) safety separating elements
 - 7) permission of openings
 - 8) roof assemblies and coverings
 - 9) ceilings
 - 10) provision of escape routes
 - 11) exit doors
 - 12) emergency routes
 - 13) width of escape routes
 - 14) marking and signposting
 - 15) lighting of exits and emergency routes
 - 16) fire detection and alarm systems
 - 17) provision of fire-fighting equipment
 - 18) water infrastructure for fire-fighting purposes
 - 19) house seats
 - 20) hydrants
 - 21) fire stopping of inaccessible concealed spaces
 - 22) protection in service shafts
 - 23) services in structural or separating elements
 - 24) smoke control (2% of gross floor area)
 - 25) air conditioning and ventilation systems
 - 26) access to buildings for fire-fighting and rescue purposes
- fire doors: close to fire doors to all units

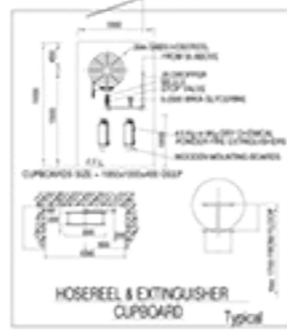

		ACTUAL	PERMISSIBLE
Zoning		Industrial	Industrial
Site area *		10 491 m ²	10 491 m ²
Height Zone		2 Storeys + basement (12.75 m)	2 Storeys (14 m)
Density Zone		n/a	n/a
Building Lines	Street	16 m from Main Road	16 m from Main Road
	Side Boundaries	7.5 m	6.0m
Parking Required		79 basement 98 open 171 total provided	4/100 office 20% x 4797 = 959 = 38 bays 2/100 industrial 60 % 5065 = 4052 = 81 bays Total = 114 bays
Coverage		3805 m ²	36.26 %
Floor Space Ratio		5065 m ²	0.48
Lettable area		4797m ²	0.5

development data

